




IMPORTANT TO READ

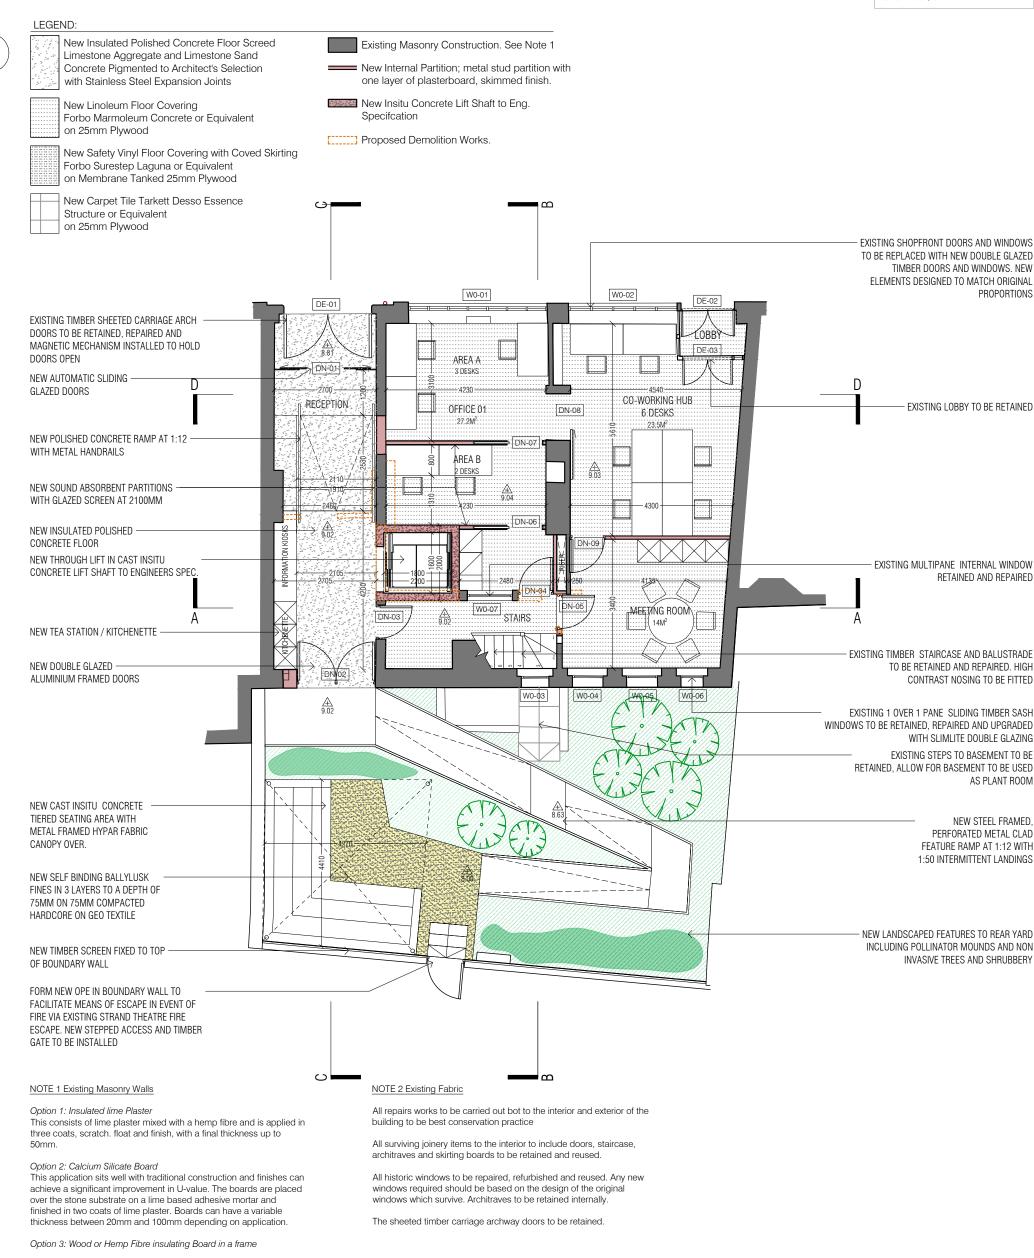



buildings are deemed safe to access.

very good U-value performance.

This option is appropriate where previous linings have been lost. The wall is framed out with tanalised timber and tightly infilled with insulating board and finished with lime plaster. This system has a

The most appropriate option will be determined by the conservation architect following extensive investigative opening up works once the



FORMER POST OFFICE CARRICK ON SUIR

COST ESTIMATE 4-Apr-22 DWG TITLE

REV. DRAWN CHECKED


PROPOSED GROUND FLOOR PLAN

E architects@jca-le 27/29 Washington Street. Cork, T12 WN8F www.jca.ie

St. Albert's House, Old Navan Road.

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IMPORTANT TO READ

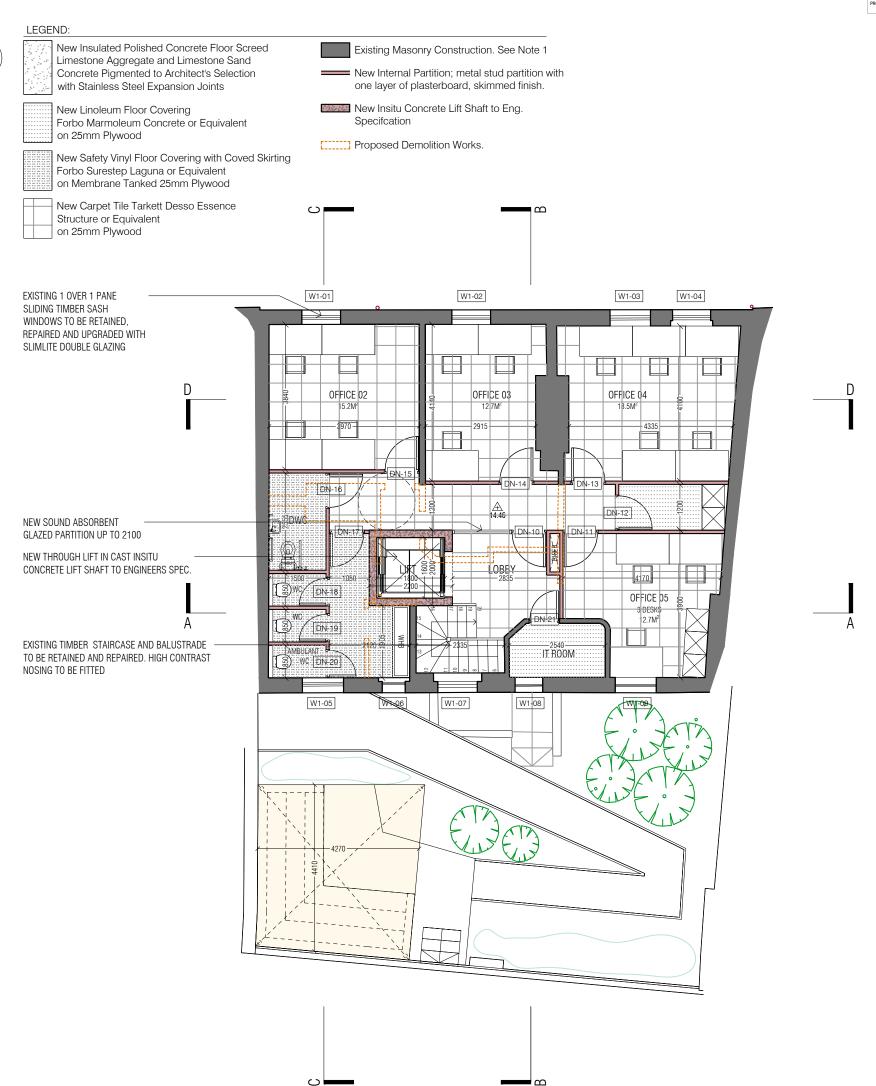

NOTE 1 Existing Masonry Walls

Option 1: Insulated lime Plaster This consists of lime plaster mixed with a hemp fibre and is applied in three coats, scratch. float and finish, with a final thickness up to

Option 2: Calcium Silicate Board This application sits well with traditional construction and finishes can achieve a significant improvement in U-value. The boards are placed over the stone substrate on a lime based adhesive mortar and finished in two coats of lime plaster. Boards can have a variable thickness between 20mm and 100mm depending on application.

Option 3: Wood or Hemp Fibre insulating Board in a frame

This option is appropriate where previous linings have been lost. The wall is framed out with tanalised timber and tightly infilled with insulating board and finished with lime plaster. This system has a very good U-value performance.

The most appropriate option will be determined by the conservation architect following extensive investigative opening up works once the buildings are deemed safe to access.

All repairs works to be carried out both to the interior and exterior of the building to be best conservation practice

All surviving joinery items to the interior to include doors, staircase, architraves and skirting boards to be retained and reused.

All historic windows to be repaired, refurbished and reused. Any new windows required should be based on the design of the original windows which survive. Architraves to be retained internally

The sheeted timber carriage archway doors to be retained.



Cork Office 27/29 Washington Street, T +353 (0)21 439 3800 E architects@jca-le

Cork, T12 WN8F

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NOTE 2 Existing Fabric

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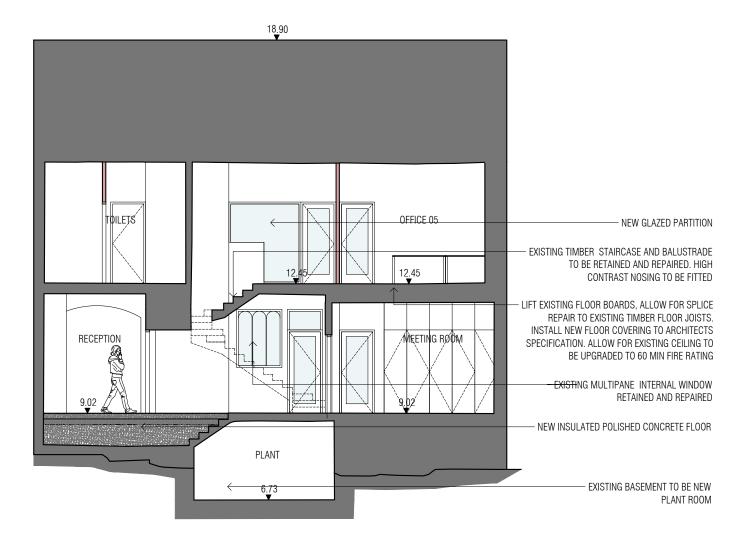
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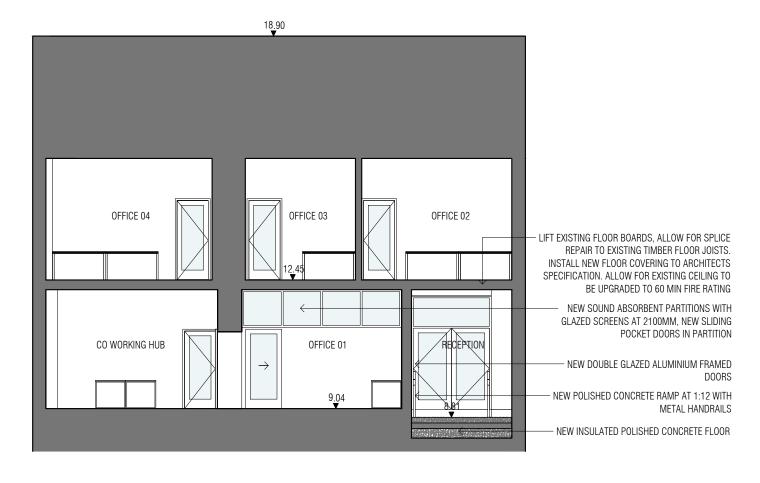
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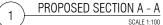
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PROPOSED FIRST FLOOR PLAN

AR101







SCALE 1:100

IMPORTANT TO READ

REVISION REV BY

PROPOSED SECTION D - D

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COST ESTIMATE | DATE | 1-APF-22

DWG TITLE


PROPOSED SECTION A-A + D-D AR200 PROJECT NUMBER 21039

SCALE 1:100

REV. DRAWN CHECKED 5.0 CO GO'C

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Cork, T12 WN8F Dunboyne, Co. Meath, A86K856



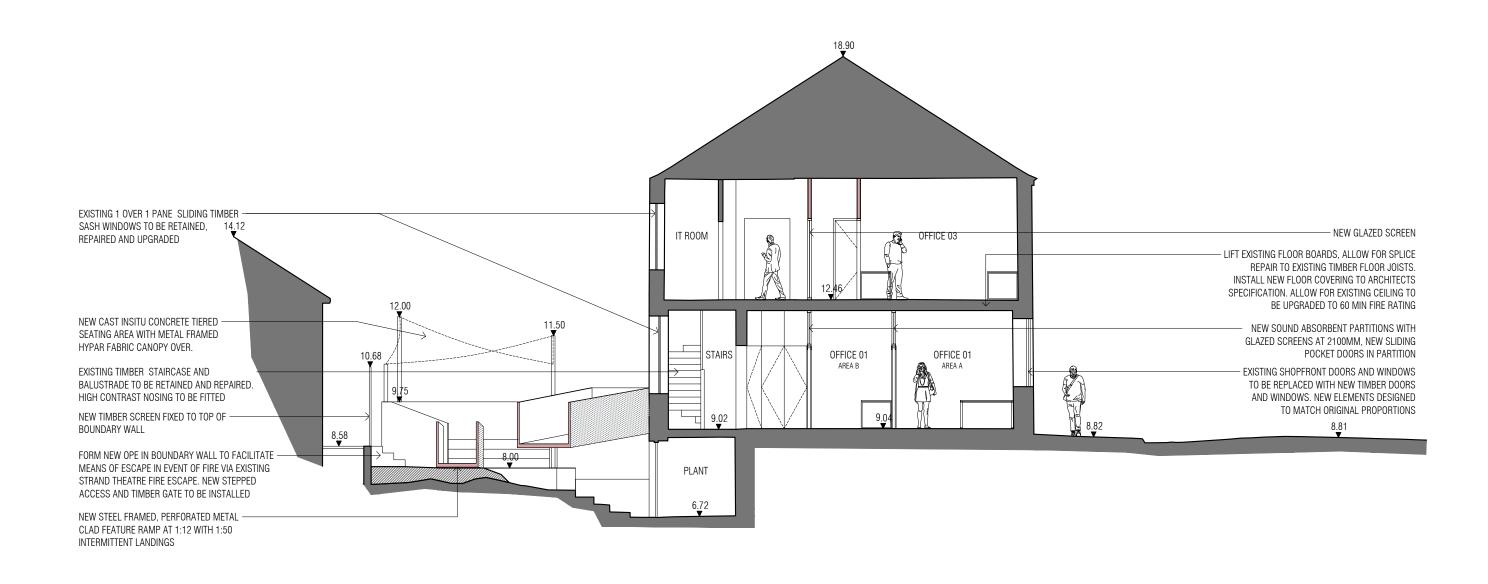

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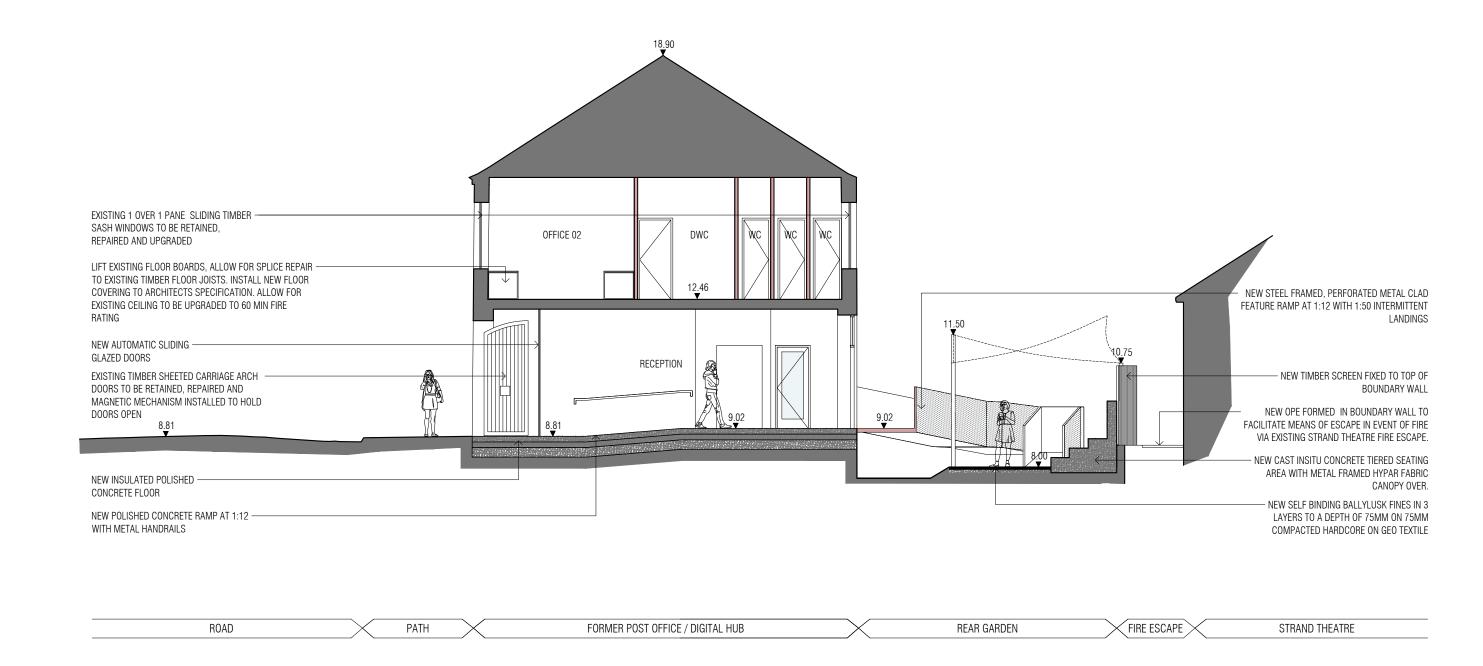
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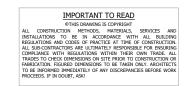
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PATH

COST ESTIMATE | DATE | 1-APF-22 SCALE 1:100 REV. DRAWN CHECKED 5.0 CO GO'C DWG TITLE PROPOSED SECTION B-B AR201 PROJECT NUMBER

ROAD













44 MAIN STREET PROPOSED DIGITAL HUB 42 MAIN STREET

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SCALE 1:100

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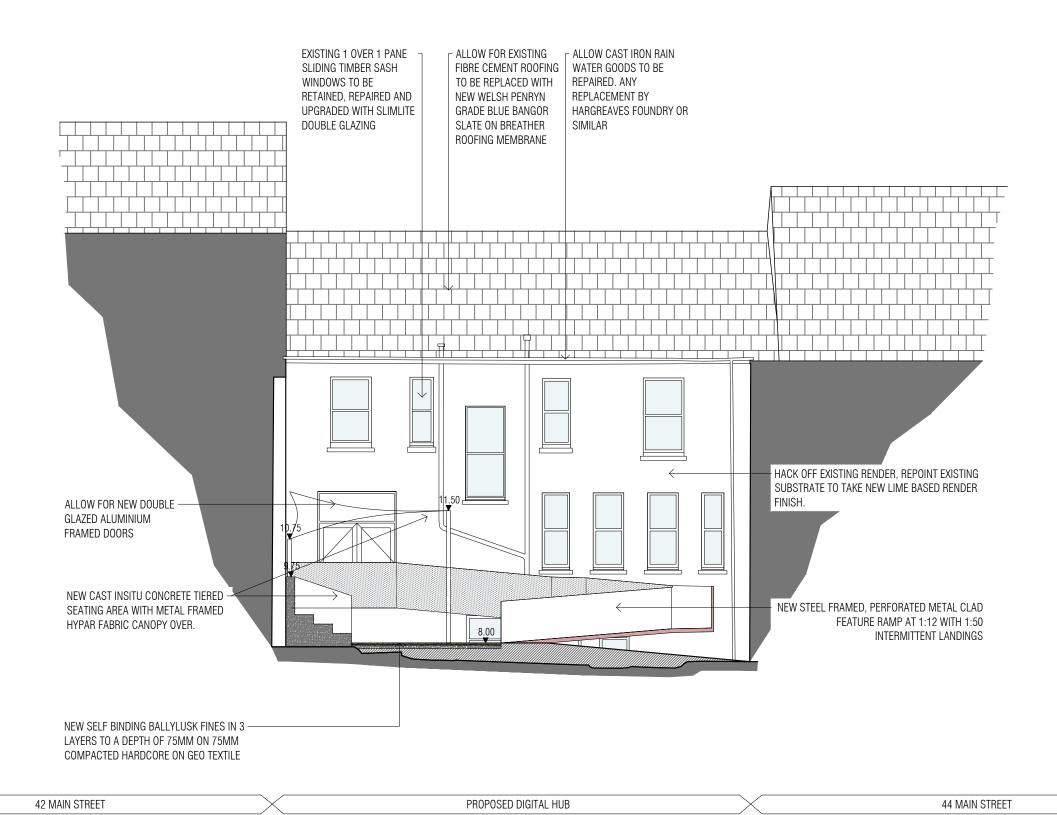


COST ESTIMATE LAPRE 2 S C A L E 1:100 REV. DRAWN CHECKED GO'C DWG TITLE PROPOSED NORTH ELEVATION

PROJECT NUMBER

AR300

St. Albert's House, Old Navan Road, 27/29 Washington Street. Cork, T12 WN8F Dunboyne, Co. Meath, A86K856 TIPPERARY CO. COUNCIL



PROPOSED REAR YARD / SOUTH ELEVATION SCALE 1:100

IMPORTANT TO READ







SCALE 1:100 REV. DRAWN CHECKED 5.0 CO GO'C DWG TITLE PROPOSED SOUTH ELEVATION